



	SITE DATA		VICINITY MAP (NOT TO SCALE):
	PARCEL ID:	R05718-009-020-000	L L L L L L L L L L L L L L L L L L L
	CURRENT ZONING:	R-5 (CD) CD-13-117 & SU-7-117	AL DE LANDFALL
	PROPOSED ZONING:	R-5 (CD) CD-13-117 & SU-7-117	A ANG ENG
	CAMA LAND USE CLASSIFICATION:	CONSERVATION & WATERSHED RESOURCE PROTECTION	WRIGHTWILLE AVE.
	PROJECT ADDRESS:	1308 AIRLIE RD. WILMINGTON, NC 28403	RILLE RD. PDC. Site
	CURRENT OWNER:	JIMMY WARREN, LLC 206 CAUSEWAY DR., UNIT 171 WRIGHTSVILLE BEACH, NC 28480	WRIGHTSVILLE BEACH
	TOTAL ACREAGE IN PROJECT BOUNDARY	± 0.7 ac. (30,616 S.F.)	REVISIONS
	PROPOSED USE:	PARKING FACILITY	2-14-17 REVISED DUMPSTER ENCLOSURE AND ADJACENT PARKING AREAS.
	BUILDING SIZE:	4,095 S.F. (ROOF)	11-2-21 REVISED SITE DATA TABLE. 1-11-22 REVISED PER TRC COMMENTS.
	BUILDING HEIGHT:	± 32' - 2 STORY (35' MAX)	
	BUILDING SETBACKS: FRONT: SIDE: REAR:	REQUIRED= 20' REQUIRED= 7' REQUIRED= 15'	
& TIE RB	CALCULATION FOR BUILDING COVERAGE: PROPOSED COVERAGE	300 S.F. ÷ 30,616 S.F. = 0.98%	в (7
MAIN	EXISTING ON-SITE IMPERVIOUS AREAS TO R GRAVEL PARKING:	EMAIN: 15,878 S.F.	L JJ(^{ng.col}
OMMERCIAL WAY APRON.	PROPOSED ON-SITE IMPERVIOUS AREAS: DUMPSTER "HOUSE": GRAVEL PARKING PAVED PARKING: CONCRETE SIDEWALK: TOTAL	300 S.F. 3,615 S.F. 2,735 S.F. 3,343 S.F. 9,993 S.F.	ASTAL AG, PLLC Unit E-7 olina 28403 .8983 .8983 .8983 . P-0662
T	TOTAL ON-SITE IMPERVIOUS AREA: PROPOSED: EXISTING TO REMAIN: TOTAL:	9,993 S.F. 15,878 S.F. 25,871 S.F. ÷ 30,616 S.F. = 84.5%	COA ERIN ander Dr. U 910.859.8 intracoasta Number:
	EXISTING SEWER & WATER DEMAND: SEWER = WATER =	o GPD o GPD	TTRA JINE 5725 Ole. nington, Phone: License
TIMBER EMAIN.	PROPOSED SEWER & WATER DEMAND: SEWER = WATER =	30 GPD 50 GPD	ENGIN ENGIN Phor Phor Licer
S MAIN CE	PROPOSED PARKING: STANDARD SIZE: COMPACT SIZE: TOTAL:	63 SPACES 16 SPACES 79 SPACES	
&G	EXISTING SEWER AND WATER DEMAND:=	o GPD	
PEDESTAL	PROPOSED SEWER AND WATER DEMAND: SEWER = WATER =	30 GPD 50 GPD	
ROAD	ESTIMATED TRIP GENERATION: (Per Trip Ger PARKING LOT AM PEAK: o*	neration Manual, 10th Edition): PM PEAK: o* DAILY: o*	۲Ţ
R/W CONCRETE LL	*EXISTING PARKING FACILITY WITH NO INC	REASE IN PARKING PROPOSED.	RAINAGE LAN LACE N, NC
			D D ON

DOCKSIDE PLACE PARKING LOT **CONSTRUCTION PLANS APPROVED 1/12/22** SWP 2022001 JW, TB, MB, BM, CW

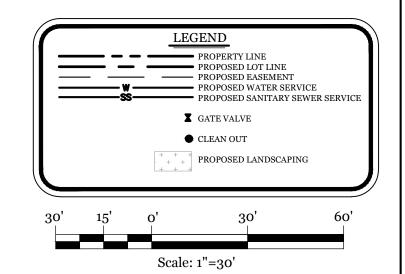

CLIENT INFORMATION:

Jimmy Warr Doug Leech 206 Causewa Wrightsville 910-208-073	ay Dr., I Beach,	Unit 171	
DRAWN:	JAE	SHEET SIZE:	24x36
CHECKED:	CDC	DATE:	1/29/18
APPROVED:	CDC	SCALE:	1" = 30'
PROJECT NUMBE	ER:	2021-037	
DRAWING NUME	BER:	C-1	0.0E.4

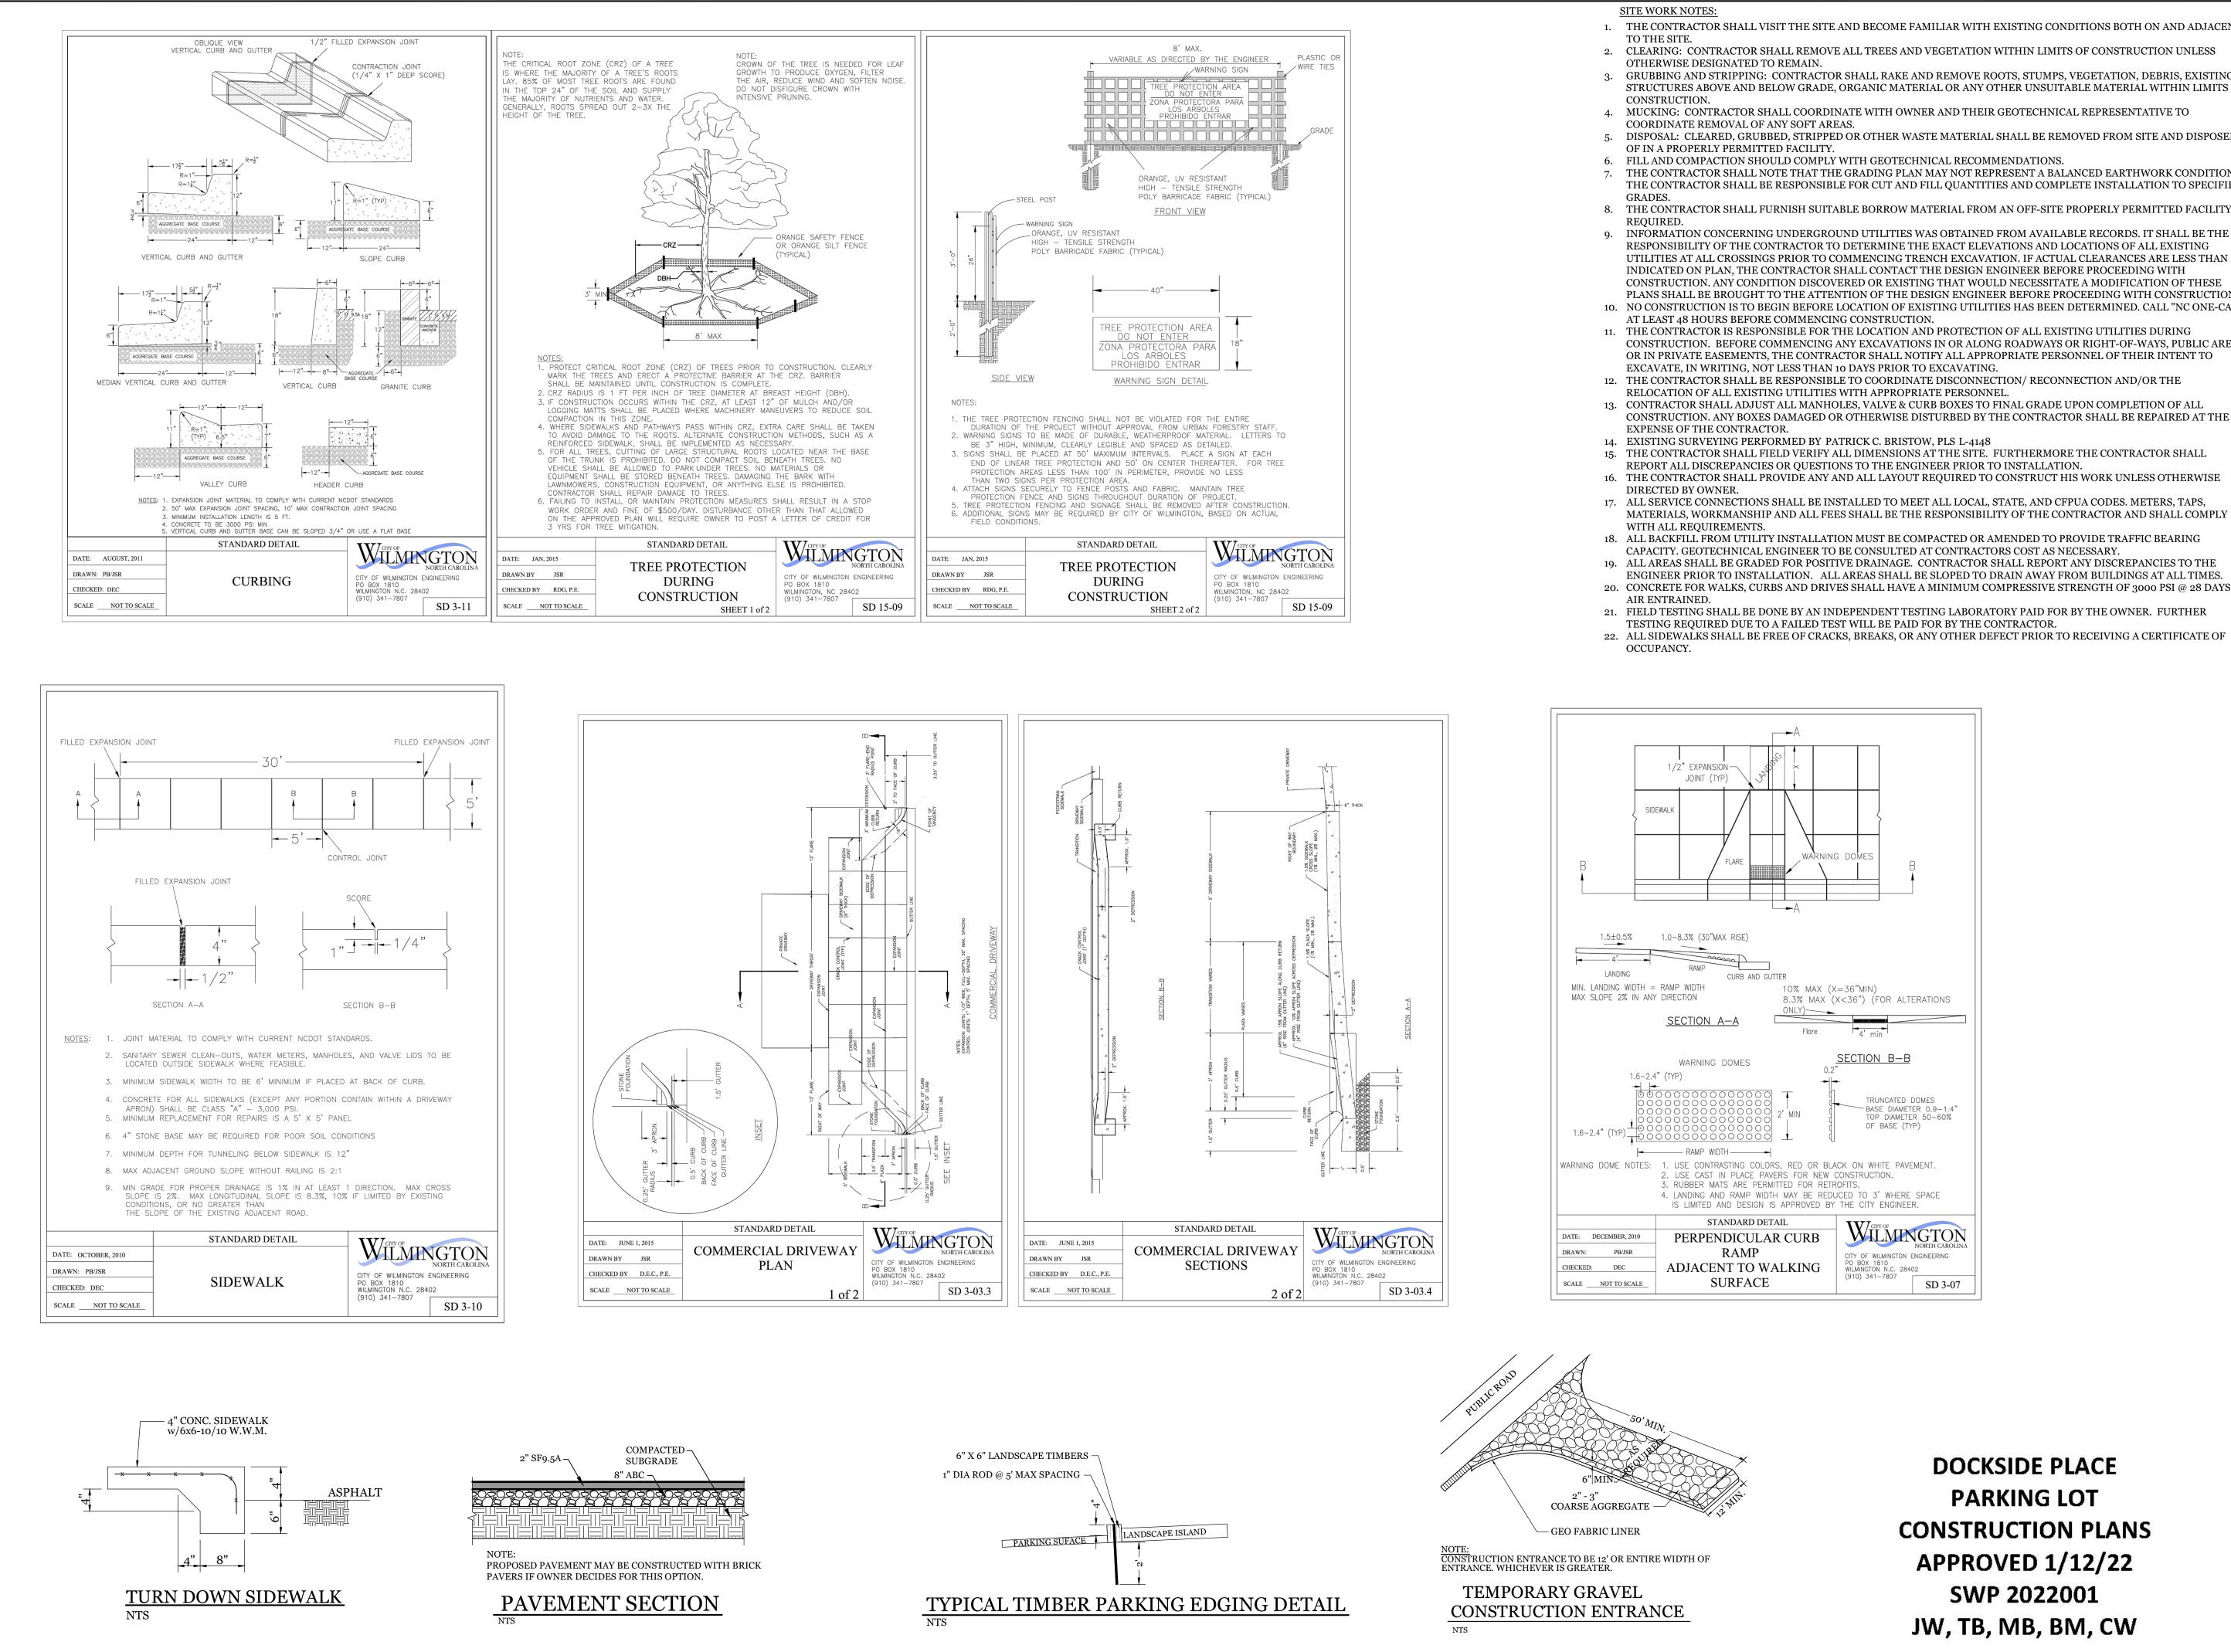

1. THE CONTRACTOR SHALL VISIT THE SITE AND BECOME FAMILIAR WITH EXISTING CONDITIONS BOTH ON AND ADJACENT

3. GRUBBING AND STRIPPING: CONTRACTOR SHALL RAKE AND REMOVE ROOTS, STUMPS, VEGETATION, DEBRIS, EXISTING STRUCTURES ABOVE AND BELOW GRADE, ORGANIC MATERIAL OR ANY OTHER UNSUITABLE MATERIAL WITHIN LIMITS OF

4. MUCKING: CONTRACTOR SHALL COORDINATE WITH OWNER AND THEIR GEOTECHNICAL REPRESENTATIVE TO

5. DISPOSAL: CLEARED, GRUBBED, STRIPPED OR OTHER WASTE MATERIAL SHALL BE REMOVED FROM SITE AND DISPOSED

7. THE CONTRACTOR SHALL NOTE THAT THE GRADING PLAN MAY NOT REPRESENT A BALANCED EARTHWORK CONDITION. THE CONTRACTOR SHALL BE RESPONSIBLE FOR CUT AND FILL QUANTITIES AND COMPLETE INSTALLATION TO SPECIFIED

8. THE CONTRACTOR SHALL FURNISH SUITABLE BORROW MATERIAL FROM AN OFF-SITE PROPERLY PERMITTED FACILITY AS

RESPONSIBILITY OF THE CONTRACTOR TO DETERMINE THE EXACT ELEVATIONS AND LOCATIONS OF ALL EXISTING UTILITIES AT ALL CROSSINGS PRIOR TO COMMENCING TRENCH EXCAVATION. IF ACTUAL CLEARANCES ARE LESS THAN INDICATED ON PLAN, THE CONTRACTOR SHALL CONTACT THE DESIGN ENGINEER BEFORE PROCEEDING WITH CONSTRUCTION. ANY CONDITION DISCOVERED OR EXISTING THAT WOULD NECESSITATE A MODIFICATION OF THESE PLANS SHALL BE BROUGHT TO THE ATTENTION OF THE DESIGN ENGINEER BEFORE PROCEEDING WITH CONSTRUCTION. 10. NO CONSTRUCTION IS TO BEGIN BEFORE LOCATION OF EXISTING UTILITIES HAS BEEN DETERMINED. CALL "NC ONE-CALL"

11. THE CONTRACTOR IS RESPONSIBLE FOR THE LOCATION AND PROTECTION OF ALL EXISTING UTILITIES DURING CONSTRUCTION. BEFORE COMMENCING ANY EXCAVATIONS IN OR ALONG ROADWAYS OR RIGHT-OF-WAYS, PUBLIC AREAS OR IN PRIVATE EASEMENTS, THE CONTRACTOR SHALL NOTIFY ALL APPROPRIATE PERSONNEL OF THEIR INTENT TO

12. THE CONTRACTOR SHALL BE RESPONSIBLE TO COORDINATE DISCONNECTION/ RECONNECTION AND/OR THE

13. CONTRACTOR SHALL ADJUST ALL MANHOLES, VALVE & CURB BOXES TO FINAL GRADE UPON COMPLETION OF ALL CONSTRUCTION. ANY BOXES DAMAGED OR OTHERWISE DISTURBED BY THE CONTRACTOR SHALL BE REPAIRED AT THE

15. THE CONTRACTOR SHALL FIELD VERIFY ALL DIMENSIONS AT THE SITE. FURTHERMORE THE CONTRACTOR SHALL


16. THE CONTRACTOR SHALL PROVIDE ANY AND ALL LAYOUT REQUIRED TO CONSTRUCT HIS WORK UNLESS OTHERWISE 17. ALL SERVICE CONNECTIONS SHALL BE INSTALLED TO MEET ALL LOCAL, STATE, AND CFPUA CODES. METERS, TAPS,

MATERIALS, WORKMANSHIP AND ALL FEES SHALL BE THE RESPONSIBILITY OF THE CONTRACTOR AND SHALL COMPLY


CAPACITY. GEOTECHNICAL ENGINEER TO BE CONSULTED AT CONTRACTORS COST AS NECESSARY. 19. ALL AREAS SHALL BE GRADED FOR POSITIVE DRAINAGE. CONTRACTOR SHALL REPORT ANY DISCREPANCIES TO THE ENGINEER PRIOR TO INSTALLATION. ALL AREAS SHALL BE SLOPED TO DRAIN AWAY FROM BUILDINGS AT ALL TIMES. 20. CONCRETE FOR WALKS, CURBS AND DRIVES SHALL HAVE A MINIMUM COMPRESSIVE STRENGTH OF 3000 PSI @ 28 DAYS -


21. FIELD TESTING SHALL BE DONE BY AN INDEPENDENT TESTING LABORATORY PAID FOR BY THE OWNER. FURTHER 22. ALL SIDEWALKS SHALL BE FREE OF CRACKS, BREAKS, OR ANY OTHER DEFECT PRIOR TO RECEIVING A CERTIFICATE OF

DOCKSIDE PLACE
PARKING LOT
CONSTRUCTION PLANS
APPROVED 1/12/22
SWP 2022001
JW, TB, MB, BM, CW

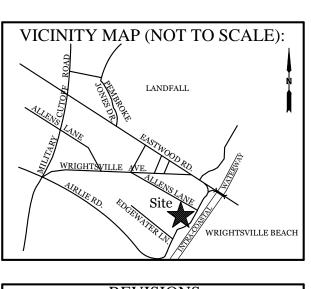

REVISIONS 11-22 REVISED TURN DOWN SIDEWALK

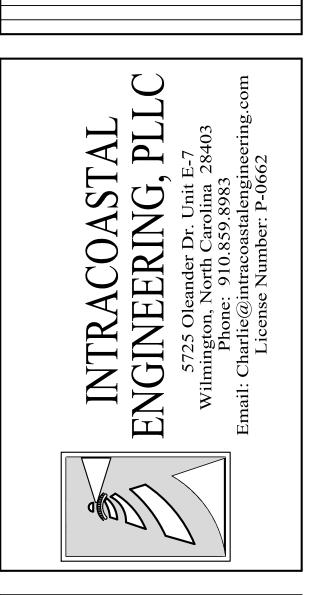


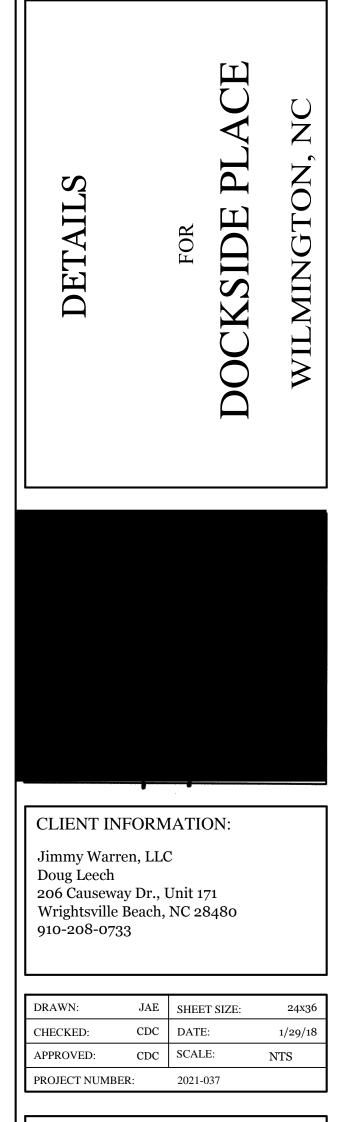

DRAWING NUMBER:

C-2

3 OF 4

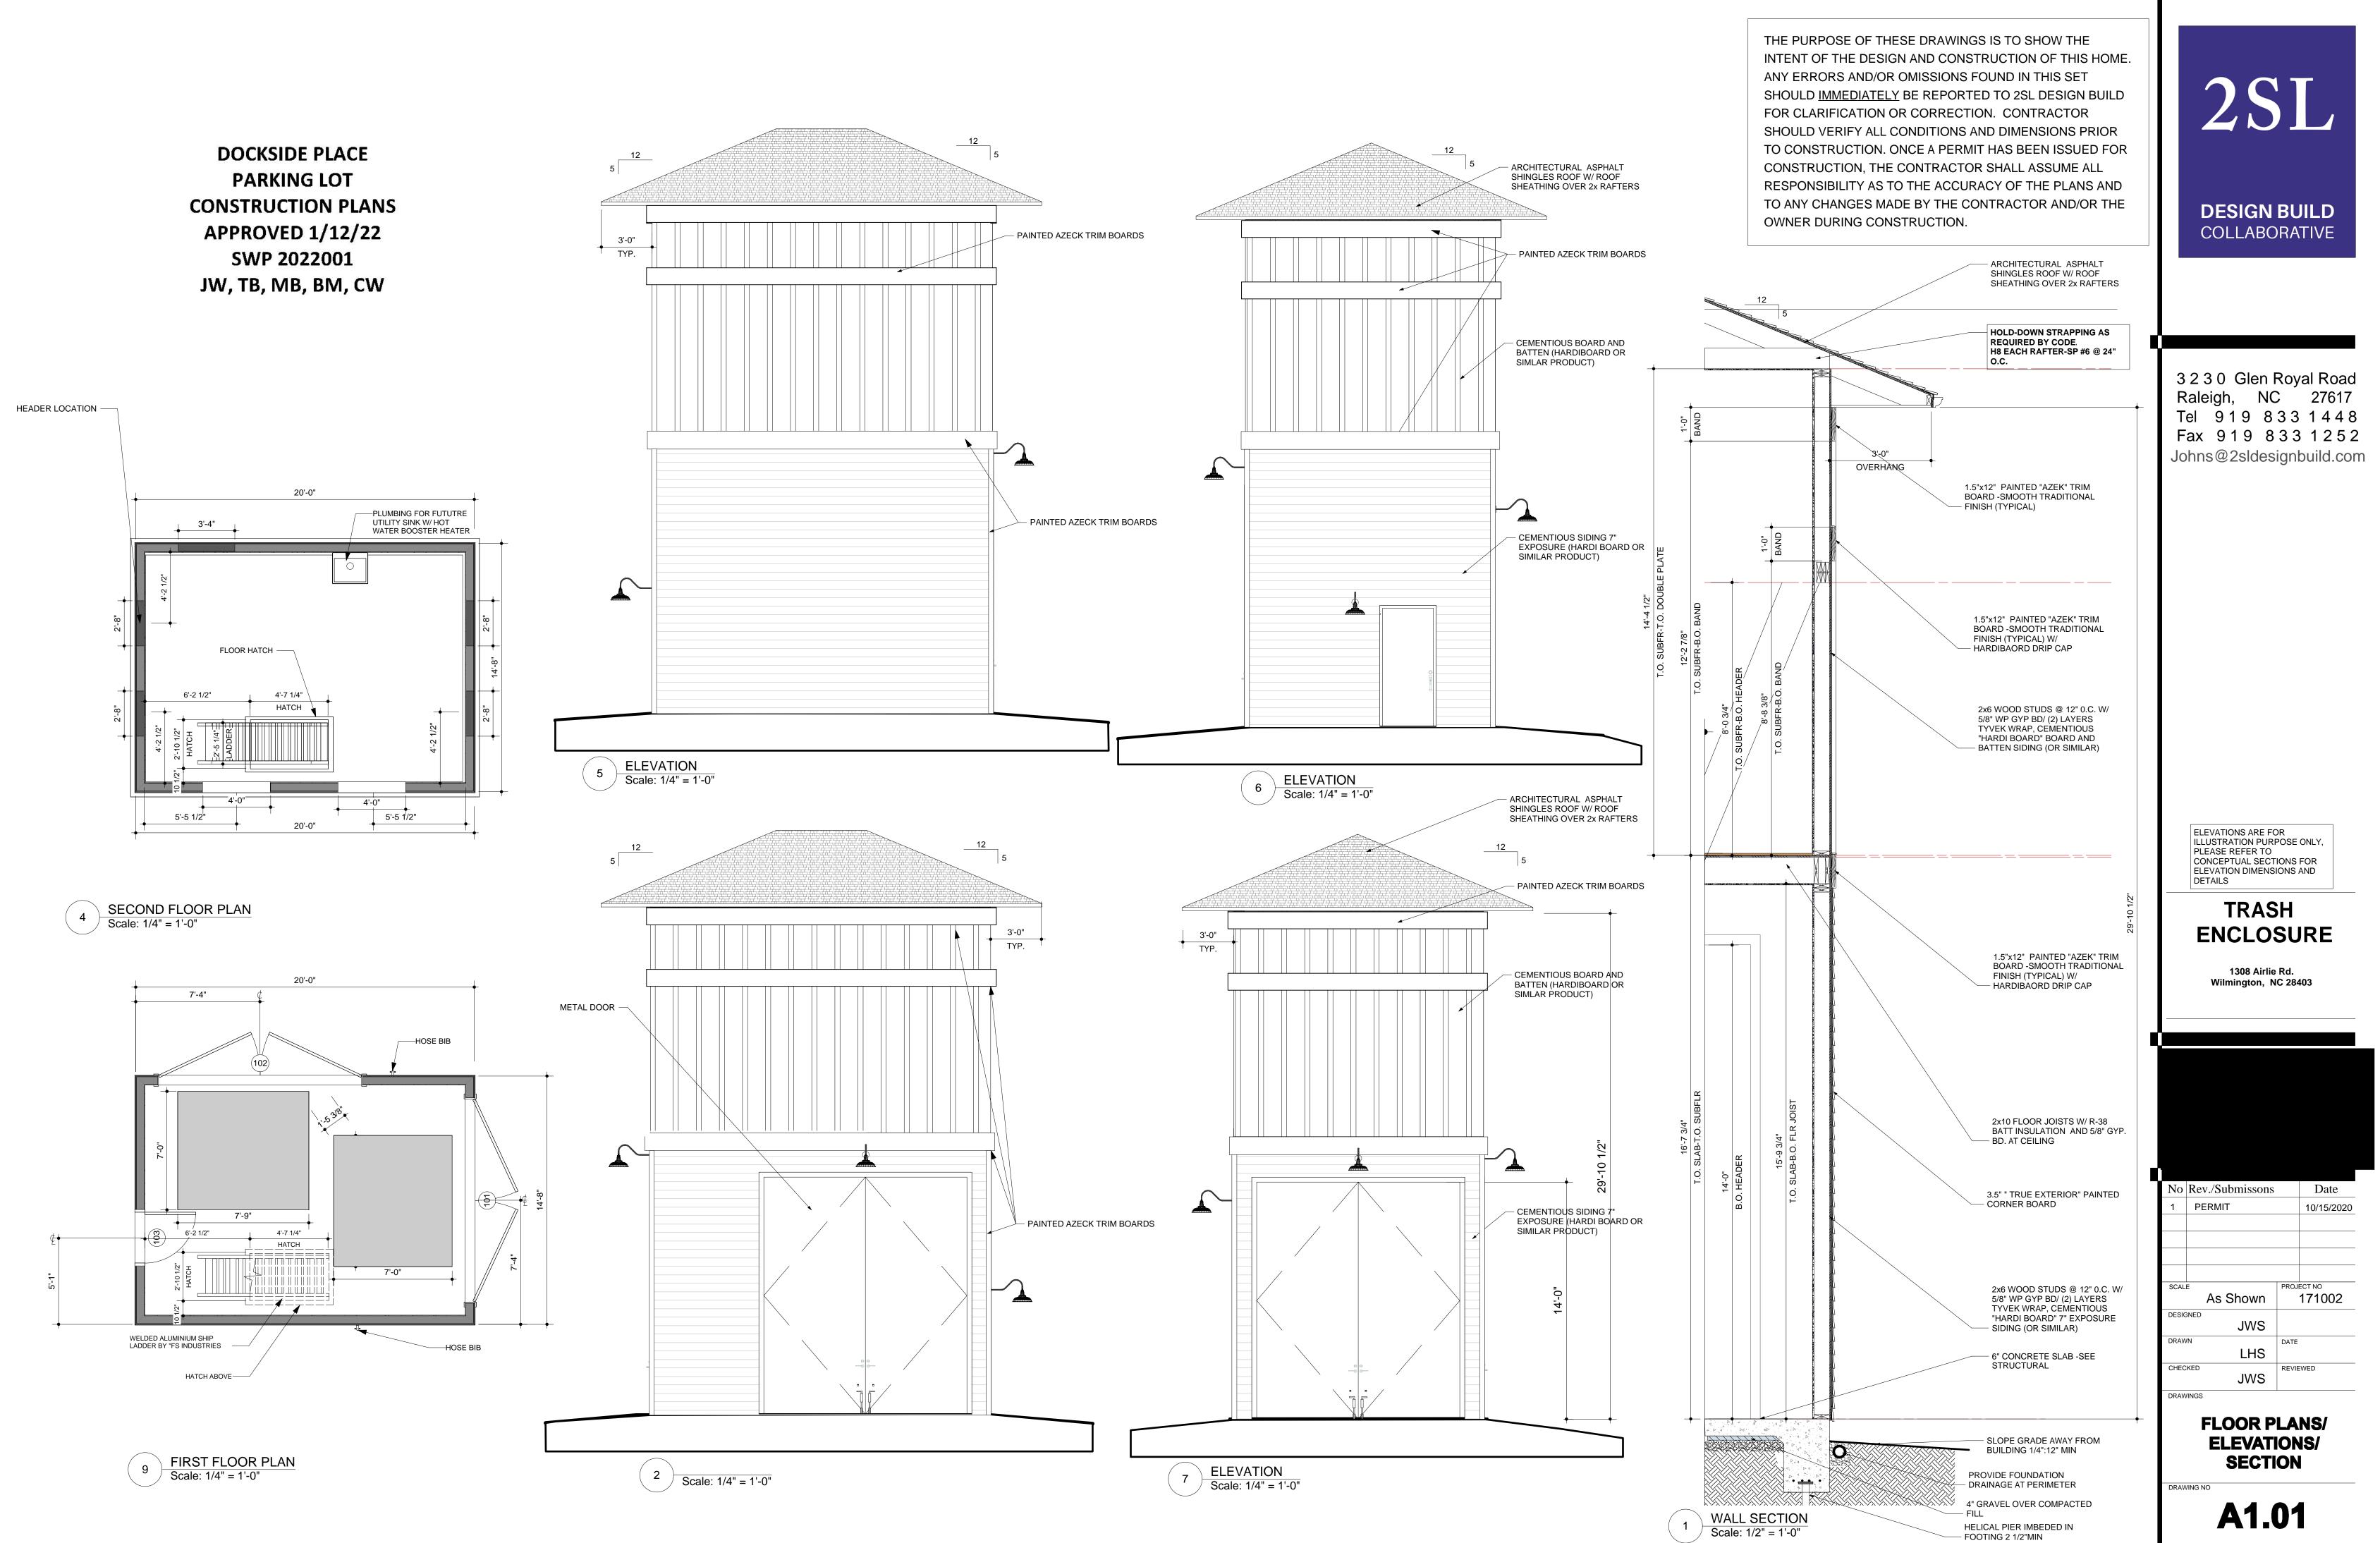

ALL WORK IS TO BE DONE IN STRICT ACCORDANCE WITH NORTH CAROLINA STATE BUILDING CODE 2012 EDITION.

